

CIAT

Existing double shop frontage to be reduced to a single unit store front. No alterations are to be made outside of sizes reduction. Block up existing shop fronting as required. Remove shop advertising above flat windows . Remove existing pilasters. PROPOSED FRONT ELEVATION

PROPOSED SIDE ELEVATION

This drawing is provided as a document to gain either Planning Permission or Building Regulation approval purposes only. It is not a guarantee that Planning Permission will be granted.


This drawing and all contents are the copyright of James Campbell Associates Ltd. No copies to be made from the drawing

This drawing and all contents are the copyright of James Campbell Associates Ltd. No copies to be made from the drawing & details within unless authorised by James Campbell Associates Ltd.

The contract for the works is between the client and his / her contractor. Contractor to visit site, study the details provided within the drawing and be familiar with both the work to be carried out in accordance with the details provided. Any stated dimension must be checked prior to any form of construction. All works and materials to comply with all relevant British Standards and carry a genuine BBA certificate. The materials specified within this drawing are a guide for the contractor as they are recognised materials with genuine BBA certificates etc. Any contractor who decides to use any different materials than that noted on the drawing must inform James Campbell Associates Ltd.

Any discrepancies discovered or items found that where not visible at the time of the initial survey should be reported to James Campbell Associates Ltd for consultation with our client.

## **CONSTRUCTION NOTES:-**

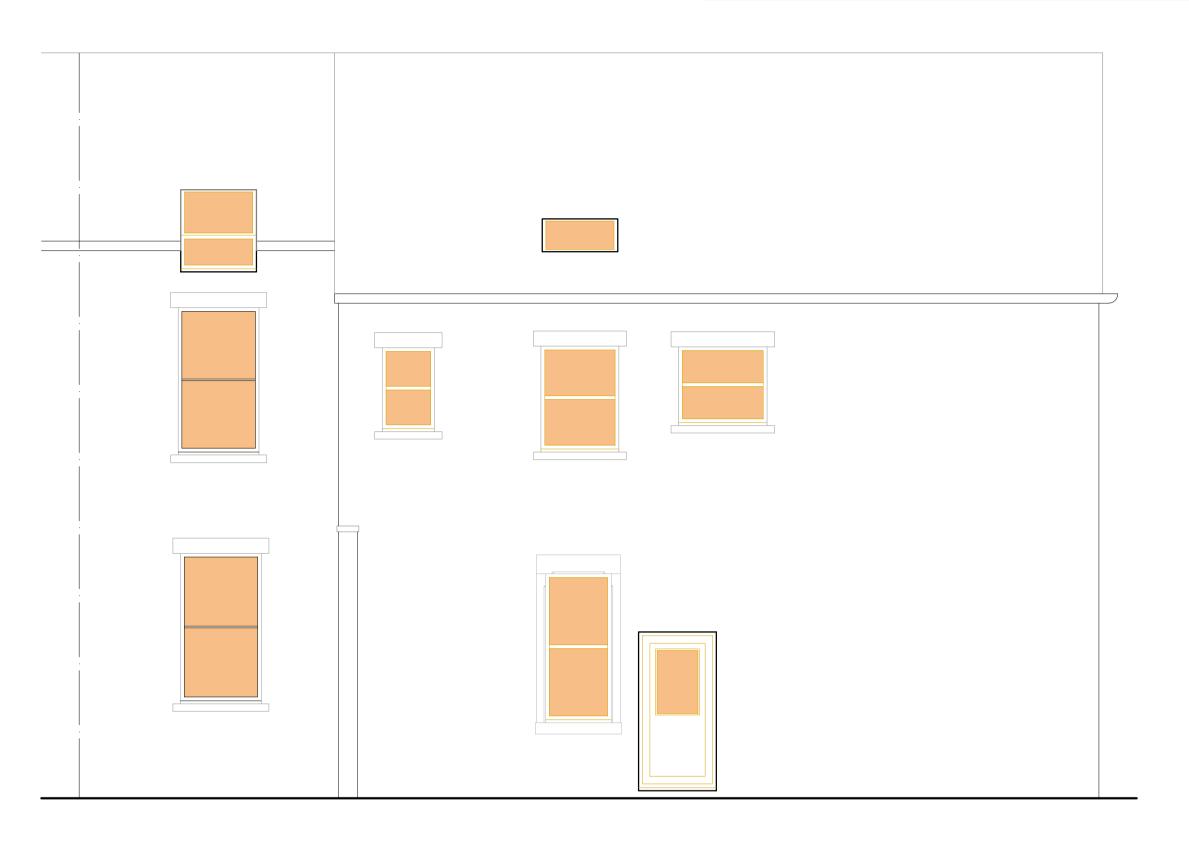

### PROPOSED REAR ELEVATION



obell House Tel: 0170
Rochdale Road Mob: 0781

ove

dale Email: admi


Ernail: admin@jamescampbellassociates.co.uk
Web: www.jamescampbellassociates.co.uk

OJECT Web: www.jamescampbellass

# PROPOSED RESIDENTIAL CONVERSION / REFURB LOCATION

21 & 23 Burnley Road East Waterfoot Rossendale

	DRAWN:-	Aiden Phillips-Whalley	DRAWING NUMBER:-
	DATE:-	March 2019	
	SCALE:-	1:50 at A1	19.1940.5 <mark>B</mark>
	ISSUE:-	В	

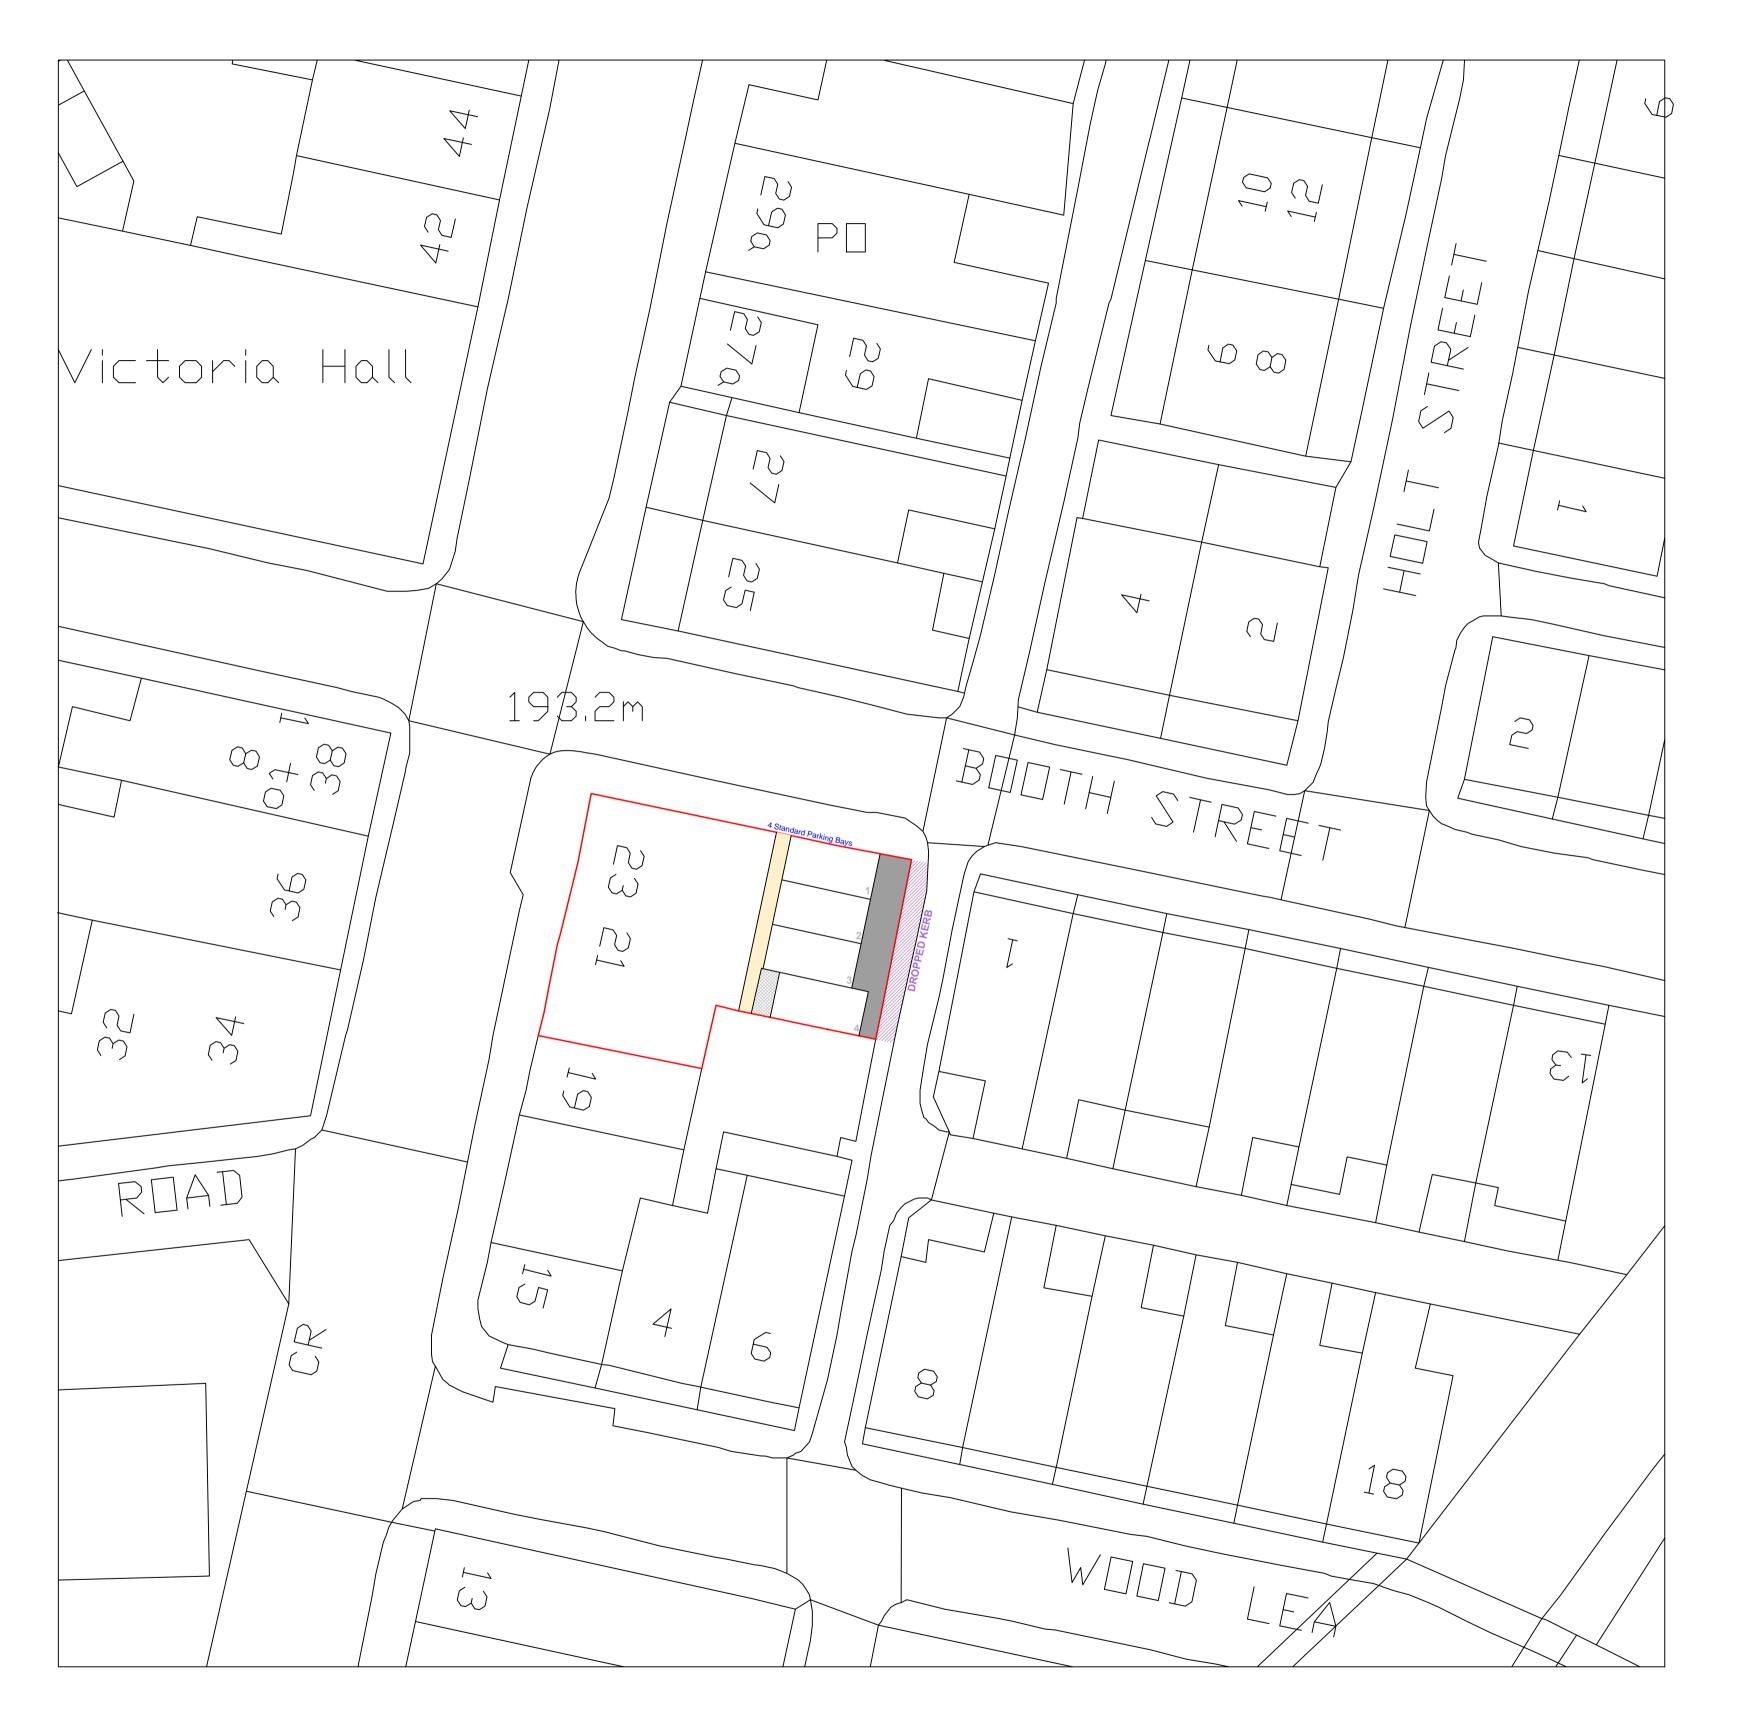

PROPOSED SITE PLAN

This drawing is provided as a document to gain either Planning Permission or Building Regulation approval purposes only. It is not a guarantee that Planning Permission will be granted.

This drawing and all contents are the copyright of James Campbell Associates Ltd. No copies to be made from the drawing & details within unless authorised by James Campbell Associates Ltd.

The contract for the works is between the client and his / her contractor. Contractor to visit site, study the details provided within the drawing and be familiar with both the work to be carried out in accordance with the details provided. Any stated dimension must be checked prior to any form of construction. All works and materials to comply with all relevant British Standards and carry a genuine BBA certificate. The materials specified within this drawing are a guide for the contractor as they are recognised materials with genuine BBA certificates etc. Any contractor who decides to use any different materials than that noted on the drawing must inform James Campbell Associates Ltd.

Any discrepancies discovered or items found that where not visible at the time of the initial survey should be reported to James Campbell Associates Ltd for consultation with our client.

## **CONSTRUCTION NOTES:-**

#### DRAWING TITLE

#### PROPOSED SITE PLAN



JAMES CAMPBELL ASSOCIATES LTD
CHARTERED ARCHITECTURAL SERVICES
THEICHARTERED INSTITUTEOF BELLDING
CIAT

mpbell House 3 Rochdale Road grove chdale

Tel: 01706 354888 Mob: 07817 623183


Email: admin@jamescampbellassociates.co.uk
Web: www.jamescampbellassociates.co.uk

PROPOSED RESIDENTIAL CONVERSION / REFURB

#### LOCATION

#### 21 & 23 Burnley Road East Waterfoot Rossendale

Ì	DRAWN:-	Aiden Phillips Whalley	DRAWING NUMBER:-
	DATE:-	March 2019	
	SCALE:-	1:50 at A1	19.1940.7 <mark>A</mark>
	ISSUE:-	Α	

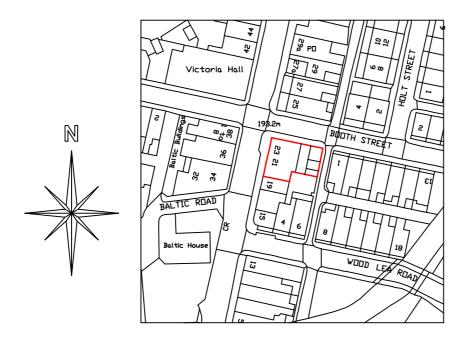

**Scale 1:1250** 

## SITE LOCATION PLAN